

LANE

GRANVILLE STREET

BUILDING DATA

CIVIC ADDRESS LEGAL DESCRIPTION PID ZONING

SUITE 700-675 W HASTINGS STREET, VANCOUVER V6B 1N2 LOT A BLOCK 14 PLAN EPP105179 DISTRICT LOT 541 NWD GROUP 1 031-465-242

CD-1

CODE REVIEW

APPLICABLE CODES

VANCOUVER BUILDING BYLAW - 2019	

BUILDING SHELL	
MAJOR OCCUPANCIES	CONFORMING TO TABLE 3.1.2.1 (UNCHANGED) D - BUSINESS AND PERSONAL SERVICES OCCUPANCIES E- MERCANTILE OCCUPANCIES
BUILDING SIZE / FIRE RATING	BUILDING AREA: 9,108.98 SQ.FT. (846.25 SQ.M.) BUILDING HEIGHT: 18 STORIES AS PER 3.2.1.1 BUILDING FACES: 2 STREET 3.2.2.10 & 3.2.2.5 BUILDING CONSTRUCTION: NON-COMBUSTIBLE BUILDING IS SPRINKLERED BUILDING COMPLIES WITH 3.2.2.55 & 3.2.2.64
SEPARATION TO MAJOR OCCUPANCIES	D / D: 0HR
WATER CLOSET (UNCHANGED)	PROVIDED - MEN : 2 TOILET + 2 URINALS WOMEN : 2 TOILET
UNIVERSAL WATER CLOSET UNCHANGED)	PROVIDED - 1 EACH SEX.
TENANT IMPROVEMENT CLASSIFICATION	OCCUPANCY - GROUP D CONFORMING TO 3.2.2.55 CONSTRUCTION TYPE - NON-COMBUSTIBLE
AREA OF INT. CONST.	APPROX. 518.37 SQ FT. (48.15 SQ.M)
WATER CLOSETS (UNCHANGED)	REQUIRED - 2 EACH SEX CONFORMING TO TABLE 3.7.2.2B PROVIDED - 2 EACH SEX
EXIT CAPACITY (UNCHANGED)	REQUIRED - 0.24" PER PERSON REQUIREMENT REQUIRED = 37 PERSONS X 0.24" = 8.8" PROVIDED = 70"

FIRE SEPARATION REQUIREMENTS

REQUIRED :

• FLOOR: 120 MINUTE F.R.R.

• MEZZANINE: 60 MINUTE F.R.R. • LOAD-BEARING SUPPORTING AN ASSEMBLY: NOT LESS THAN THAT REQUIRED FOR THE SUPPORTED ASSEMBLY.

SEPARATION OF SUITES: 3.3.1.1

• A SUITE SHALL BE SEPARATED FROM ADJOINING SUITES BY A FIRE SEPARATION HAVING A FIRE-RESISTANCE RATING NOT LESS THAN 1 HOUR. NO FIRE SEPARATION IS REQUIRED BETWEEN SUITES OF BUSINESS AND PERSONAL SERVICES OCCUPANCY.

PENETRATIONS THROUGH FIRE SEPARATIONS AND FIRE RATED ASSEMBLIES WILL HAVE FIRE CAULKING MATERIAL AND ARE SUBJECT TO THE REQUIREMENTS OF ARTICLES 3.1.9 OF THE 2019 VBBL.

INSTALL FIRE DAMPERS WITH FIRE CAULKING MATERIAL WHERE EXHAUST FAN PENETRATES FIRE SEPARATION AS PER 3.1.8.10

MAXIMUM TRAVEL DISTANCE: 3.3.1.6 & 3.4.2.5

TRAVEL DISTANCE: 147.6' (45.0 M) IN A FLOOR AREA THAT CONTAINS AN OCCUPANCY OTHER THAN HIGH-HAZARD, AND IS SPRINKLERED THROUGHOUT AS PER 3.4.2.5.(C)

MINIMUM NUMBER OF EXITS: 3.3.1.5 & 3.4.2.1 MINIMUM ONE EXIT

(MAXIMUM FLOOR AREA OF 3,229.17 SQ FT (300 SQ M) FOR ONE EXIT PERMITTED IN GROUP D.) TRAVEL DISTANCE: 82.02' (25.0 M) AS PER TABLE 3.3.1.5.-B

GENERAL NOTES

ALL WORKMANSHIP AND METHODS OF C	ONS
CURRENT EDITION OF THE VANCOUVER	BUIL

- 2. DIMENSIONS.
- 3. CONSTRUCTION.
- MOVEMENT OF MATERIALS AND COMPONENTS INTO THE BUILDING.
- INSTALLATIONS AS WELL AS MILLWORK AND WASHROOM FIXTURING.
- MECHANICAL AND ELECTRICAL INSTALLATIONS.
- EMERGENCY LIGHTS, EXIT SIGNS, FIRE EXTINGUISHERS, SMOKE DETECTORS, FIRE PULLS AND 7. CONTRACTOR. QUALITY AND PLACEMENT TO MEET CODE REQUIREMENTS.
- DETAILS SHOWN ARE FOR APPEARANCE PURPOSE ONLY AND ARE NOT INTENDED TO FABRICATION METHODS.
- 9
- 10. MATERIALS. USE NEW MATERIALS ONLY, EXCEPT WHERE NOTED OTHERWISE.
- 11. TO CONFORM WITH THE REQUIREMENTS OF THE VBBL 2019 FOR FIRESTOPPING AND PENETRATIONS THROUGH FIRE SEPARATIONS.
- 12. PREPARATION OF NEW FLOOR FINISHES.
- 13. DISCREPANCIES TO BE REPORTED TO CANADIAN BLUEPRINT FOR CLARIFICATION PRIOR TO PROCEEDING.
- 14. CANADIAN BLUEPRINT FOR CLARIFICATION PRIOR TO PROCEEDING.
- 15.
- 16. CONTRACTOR TO MAINTAIN CONTINUITY OF EXISTING FIRE SEPARATIONS, AND REPAIR FIRE

SCOPE OF WORK

- ASSOCIATED WITH THIS WORK.
- NO CHANGES OF BUILDING AREA OR FLOOR AREA IS ASSOCIATED WITH THIS WORK.
- NO CHANGES OF THE BUILDING'S FIRE RESISTANCE RATINGS OF EXISTING FLOORS AND
- 4. NO CHANGE OF USE IS ASSOCIATED WITH THIS WORK.
- 5. NO CHANGE OF SPRINKLER SYSTEM IS ASSOCIATED WITH THIS WORK
- 6. SUPPLY AND INSTALL NEW NON-LOADBEARING WALLS.
- 7 SUPPLY AND INSTALL NEW INTERIOR DOORS AND HARDWARE.
- SUPPLY AND INSTALL ELECTRICAL AND DATA OUTLETS.
- 10. SUPPLY AND INSTALL LIGHT FIXTURES.

ABBREVIATIONS

EX - EXISTING P - PROPOSED CH - CEILING HEIGHT F.R.R - FIRE RESISTANCE RATING U/S - UNDERSIDE **F.S - FIRE SEPARATION** T.D - TRAVEL DISTANCE

VBBL PART 11 - DIV B							
PROJECT TYPES AND RELATED CATEGORIES OF WORK UPGRADE LEVELS REQUIRED			GRADE LEVELS REQUIRED				
	REHABILITATION PROJECT: MINO	DR RENOVATION • F		INOR RENOVATION • F1,S2,N1,A		,S2,N1,A2	
UPGRADE	OBJECTIVE STATEMENT	STATEMENT ALTERNATIVE ACCEPTA		SCOPE OF WORK			
F1 / FIRE AND LIFE SAFETY	EXITING TO BE REVIEWED TO ENSURE THAT THE EXITS DO NOT PRESENT AN UNSAFE CONDITION.	PROJECT AREA – EXITS TO BE UPGRADED WITH RESPECT TO NUMBER, CAPACITY, AND FIRE SEPARATIONS ONLY.		NO CHANGE REQUIRED TO SAFETY OR EXITS, EMERGENCY LIGHTS PROVIDED			
S2 / STRUCTURAL	LIMITED STRUCTURAL UPGRADE REQUIRED IN ORDER TO PROVIDE MINIMUM PROTECTION TO BUILDING OCCUPANTS DURING A SEISMIC EVENT WITHIN THE PROJECT AREA.	PROJECT AREA – NON-STRUCTURAL ELEMENTS AND FALLING HAZARDS MUST BE RESTRAINED TO RESIST LATERAL LOADS DUE TO EARTHQUAKES WITHIN THE PROJECT AREA.		NO STRUCTURAL WORK IS PROPOSED			
N1 / NON- STRUCTURAL	PROJECT AREA TO BE REVIEWED TO ENSURE SAFETY FROM OVERHEAD FALLING HAZARDS.	PROJECT AREA – RESTRAIN ALL CEILING SUPPORTING FRAMES, T-BARS ASSEMBLIES, CEILING GYPSUM WALL BOARDS, ALL OVERHEAD MECHANICAL DUCTS, SPRINKLERS, EQUIPMENT, SPRINKLER SYSTEM, OVERHEAD ELECTRICAL CONDUITS AND LIGHTS		INTERIOR WALL AND OVERHEAD SUPPORTING SYSTEMS ARE TO BE RESTRAINED			
A2 / ACCESSIBILITY	A LIMITED LEVEL OF UPGRADE SHALL BE PROVIDED WITHIN THE PROJECT AREA TO ENSURE ACCESS FOR PERSONS WITH DISABILITIES.	PROJECT AREA – DOOR CLEARA AND AREAS OF REFUGE.	ANCES, DOOR HARDWARE,	EXISTING ACCESS MAINTAINED FOR NEW CONSTRUCTION, DOOR CLEARANCE AND OCC LOAD COMPLIANT WITH RESPECTIVE REQUIRE			

PROPOSED:

[NOT PROPOSED]

[NOT PROPOSED]

[NOT PROPOSED]

STRUCTION TO MEET REQUIREMENTS OF THE ILDING BYLAW 2019 (VBBL).

CONTRACTOR TO CONFIRM ALL DIMENSIONS ON SITE PRIOR TO COMMENCING CONSTRUCTION DISCREPANCIES TO BE REPORTED TO THE CANADIAN BLUEPRINT FOR CLARIFICATION PRIOR TO PROCEEDING. WRITTEN DIMENSIONS ON DRAWINGS SHALL HAVE PRECEDENCE OVER SCALED

MAKE GOOD ALL EXISTING CONSTRUCTION AND SURROUNDING AREAS DAMAGED DURING

CONTRACTOR TO VERIFY WITH OWNER THE AVAILABLE MEANS AND CONDITIONS AFFECTING THE

PROVIDE STRUCTURAL WALL BACKING AS REQUIRED FOR OVERHEAD AND INTERIOR DOOR

PROVIDE DRYWALL ACCESS HATCHES TO DRYWALL PARTITIONS AND CEILINGS TO SUIT

ALARMS OR ANY OTHER NECESSARY FIRE EQUIPMENT TO BE SUPPLIED AND INSTALLED BY SUB-

SUPERSEDE FABRICATION METHODS. REFER TO ALL MANUFACTURER'S SPECIFICATION FOR

CONTRACTOR TO VISIT SITE BEFORE SUBMITTING TENDER AND EXAMINE LOCAL AND EXISTING CONDITIONS ON WHICH THE WORK IS DEPENDENT. NO CONSIDERATION WILL BE GRANTED FOR MISUNDERSTANDING OF WORK TO BE DONE RESULTING FROM FAILURE TO VISIT THE SITE.

CONTRACTOR IS TO ORDER ALL MATERIALS AND FINISHES IMMEDIATELY UPON RECEIVING NOTICE OF TENDER AWARD. NOTIFY CANADIAN BLUEPRINT IMMEDIATELY OF ANY UNAVAILABLE

ALL FIRESTOPPING, FOR WORK SUPPLIED AND INSTALLED AS INDICATED ON THESE DRAWINGS,

CONTRACTOR TO FILL VOIDS IN EXISTING CONCRETE FLOOR SLAB, AND PATCH AND REPAIR IN

DIMENSIONS ARE TAKEN TO FINISHED FACE OF PARTITION OR FLOORING/CEILING FINISH U.N.O.

DISCREPANCIES IN DRAWINGS AND/OR SPECIFICATION TO BE PROMPTLY REPORTED TO

INFORMATION IN SPECIFICATION TAKES PRECEDENCE OVER INFORMATION IN THE DRAWING SET.


SEPARATIONS DAMAGED DURING THE COURSE OF THE CONSTRUCTION.


NO REDUCTION OR CHANGE IN TRAVEL DISTANCE OR EXIT/EGRESS PROVISION IS

LOAD-BEARING WALLS, COLUMNS AND BEAMS IS ASSOCIATED WITH THIS WORK.

SUPPLY AND APPLY NEW PAINT FINISH TO EXISTING SURFACES.

O.C - ON CENTER U.N.O - UNLESS NOTED OTHERWISE C.W - COME WITH

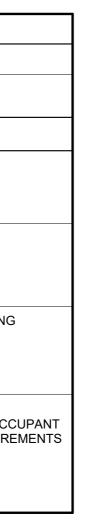

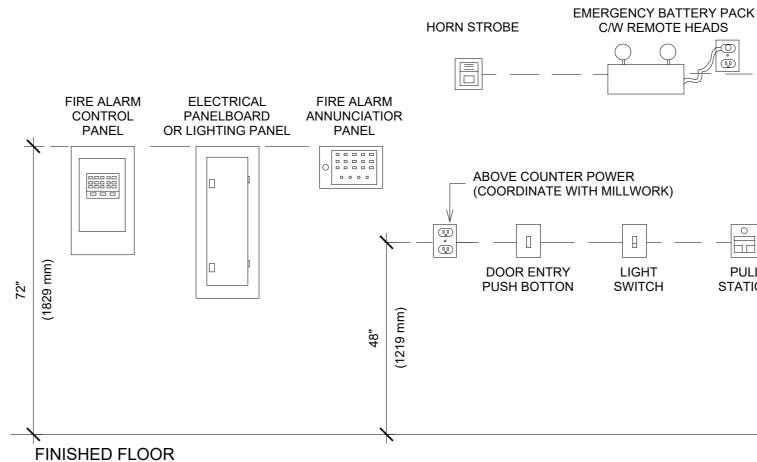

NOTES:

- MOUNTING HEIGHTS ARE TYPICAL UNLESS OTHERWISE NOTED ON THE DRAWINGS.
- ALIGN ALL DEVICES VERTICALLY AND HORIZONTALLY. COORDINATE EXIT SIGN AND EMERGENCY LIGHTING BATTERY PACKS/REMOTE HEADS LOCATIONS WITH SITE CONDITIONS FOR SITE LINE VISIBILITY.


 $1 \frac{\text{TYPICAL ELECTRICAL DEVICE MOUNTING HEIGHTS}}{1/2" = 1'_0"}$ / 1/2" = 1'-0"

WALL SCHEDULE		
	WALL	DESCRIPTION
	W1	EXISTING EXTERIOR WALL TO REMAIN. PAINT ONLY.
	W2	EXISTING INTERIOR WALL TO REMAIN. PAINT ONLY.
	W3	EXISTING INTERIOR GLASS WALL TO REMAIN.
	W4	NEW FULL HEIGHT INTERIOR WALL TO U/S OF CEILING - SEE DETAIL 2/BP1.0 1/2" GWB 2 1/2" STEEL STUDS @ 16" O.C R8 BATT INSULATION 1/2" GWB TAPED AND FINISHED ON BOTH SIDES
	W5	STRUCTURAL GLASS 8'-0" H X 10MM CLEAR TEMPERED MONOLITHIC GLASS ON CLEAR ANODIZED ALUMINUM CHANNELS TOP AND BOTTOM, 1/8" CLEAR SILICONE SIDE AND BUTT JOINTS. NEW DRYWALL BULKHEAD ABOVE C/W PLY BACKING FOR GLAZING AND/OR RECESSED CLOSERS AS REQ'D FROM 8'-0"AF TO UNDERSIDE OF STRUCTURE: 3 5/8" METAL STUDS @ 16" O.C. C/W ONE LAYER OF 1/2" GWB BOTH SIDES - TAPE TO LEVEL 4 FINISH. R12 BATT INSULATION IN CAVITY. PROVIDE ADDITIONAL SEISMIC CROSS- BRACING AS REQUIRED BY CODE.

DOOR SCHEDULE DESCRIPTION EXISTING DOOR TO REMAIN. EXISTING DOOR TO BE RELOCATED. NEW TEMPERED GLASS INTERIOR DOOR - 3'-0" X 8'-0" X 12MM CLEAR TEMPERED GLASS ON TOP & BOTTOM PIVOTS WITH PATCH FITTINGS. CONCEALED HOLD-OPEN CLOSER ABOVE - DRYWALL CONTRACTOR TO CONSTRUCT 4-5/8" DRYWALL BULKHEAD TO THE UNDERSIDE OF STRUCTURE AND PROVIDE RECESSED POCKET C/W 3/4" PLY BACKING. BUILDING STANDARD BACK TO BACK PULL HANDLES TO MATCH EXISTING - 48" TBC (CRL 18LPBS OR HITECH CD-LADDER18 - CONFIRM). FLOOR MOUNTED DOORSTOP AS REQUIRED TO SUIT. EXTEND TOP SIDELITE CHANNEL BY 3" TO ACT AS

SOLID CORE, PAINT GRADE WOOD DOOR IN PAINT GRADE WOOD DOOR FRAME. DOOR TO BE 3'-0" WIDE X FULL HEIGHT (CEILING IS AT 8'-0" AFF). D2 PASSAGE SET HARDWARE TO MATCH BUILDING STANDARD


OVERHEAD STOP. ALL HARDWARE TO BE BRUSHED STAINLESS STEEL FINISH.

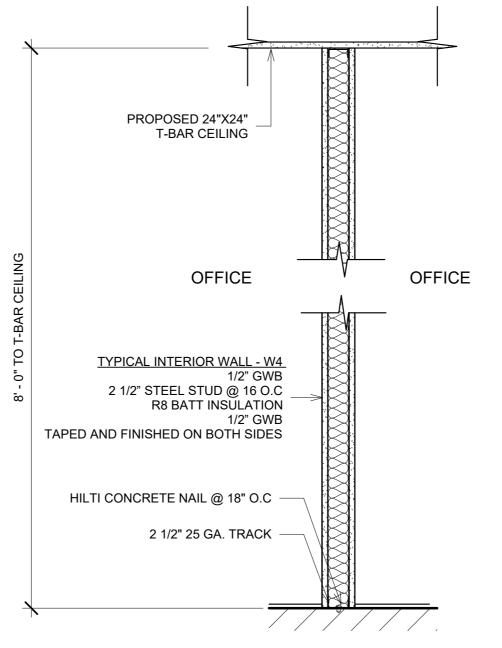



2 W4 -TYPICAL INTERIOR WALL 1" = 1'-0"

	PICTOGRAM EXIT	EMERGENCY LIGHT
<	SIGN	REMOTE HEADS
] L ION	$\overline{\bigcirc}$	T'STAT

Image: With State
Sheet ListBP0.0Site PlanBP1.0Notes & DetailsBP2.0Proposed PlanBP3.0Proposed RCPBP4.0Existing PlanImage: state of the state
Revisions No° Description Date A Started preliminary design 8/5/2024 - - - - - - - - - - - - - - - - - - - - - - - - - - - - - - - - - - - - - - -
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Applied Science Technologists & Technicians of British Columbia 34265 EDWARD VEGA CTECH
UPG Property Group Tenant Improvement
16TH Floor 675 West Hastings St, Vancouver V6B 1N2 Lot A Block 14 Plan EPP105179 District Lot 541 NWD Group 1 PID: 031-465-242
Notes & Details
Project number 1382 Date 12-AUG-2024 Drawn by EV Checked by BS/JE BP1.0 Scale As indicated

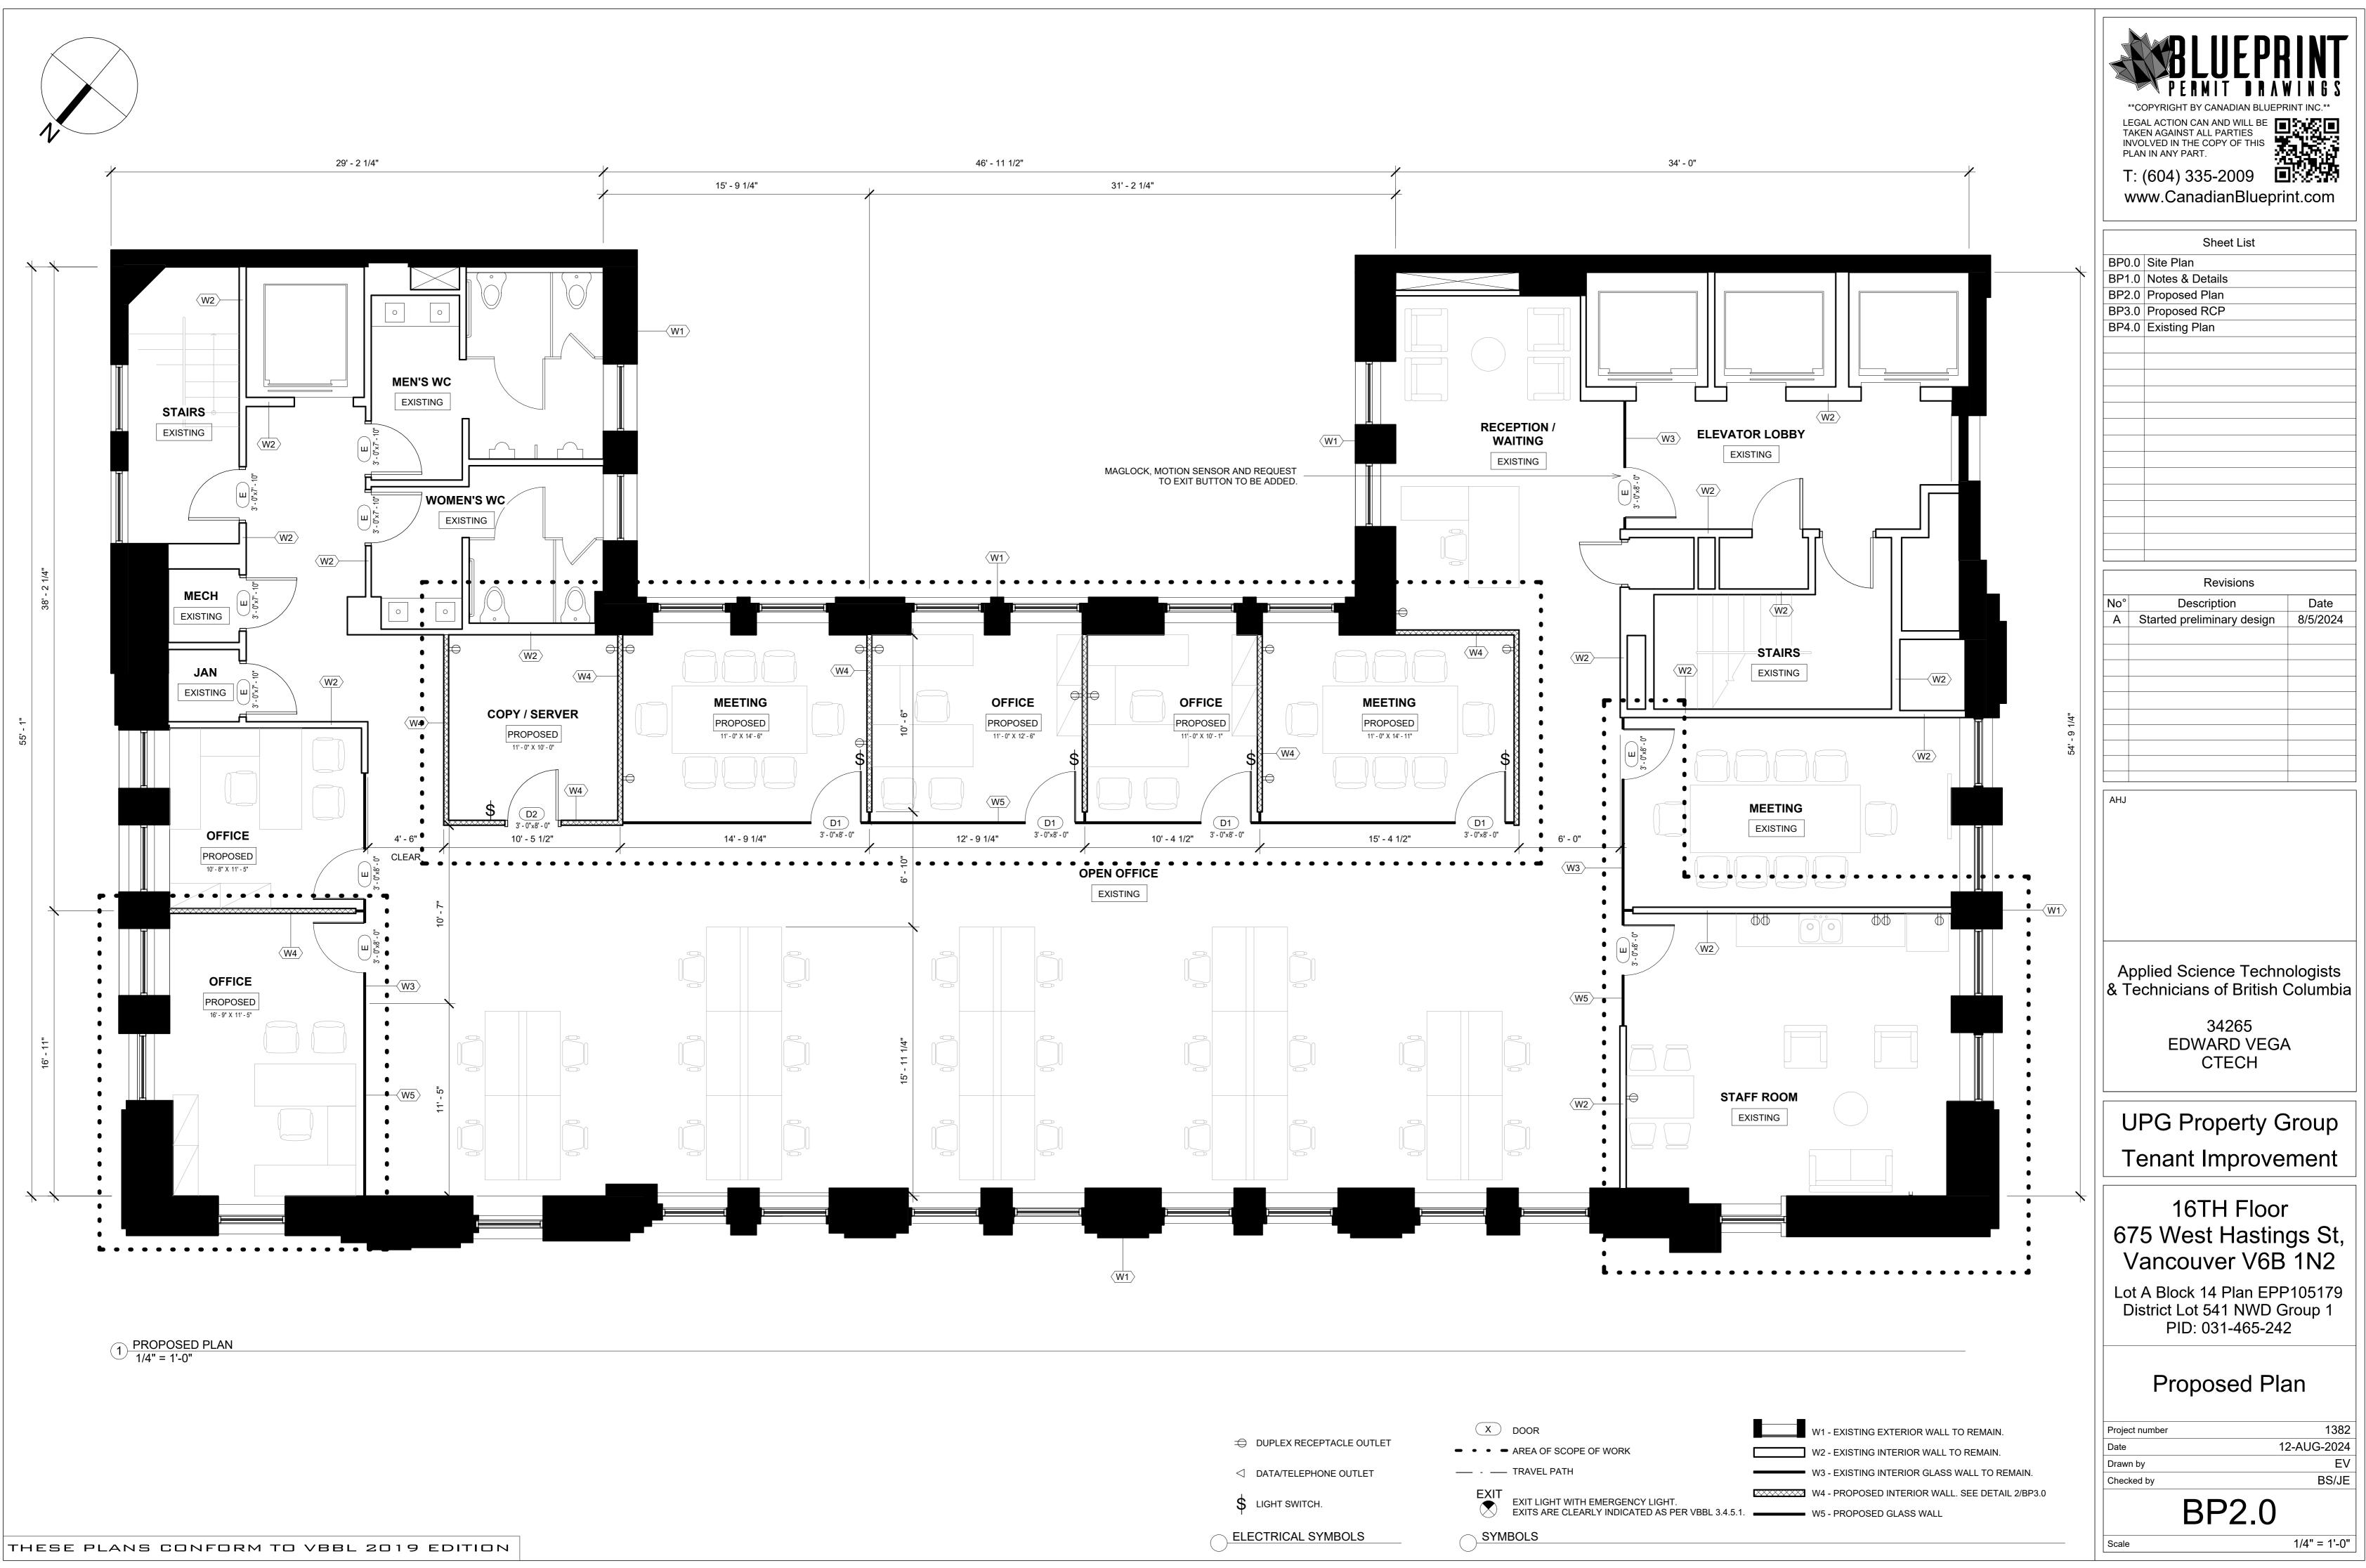

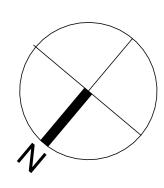

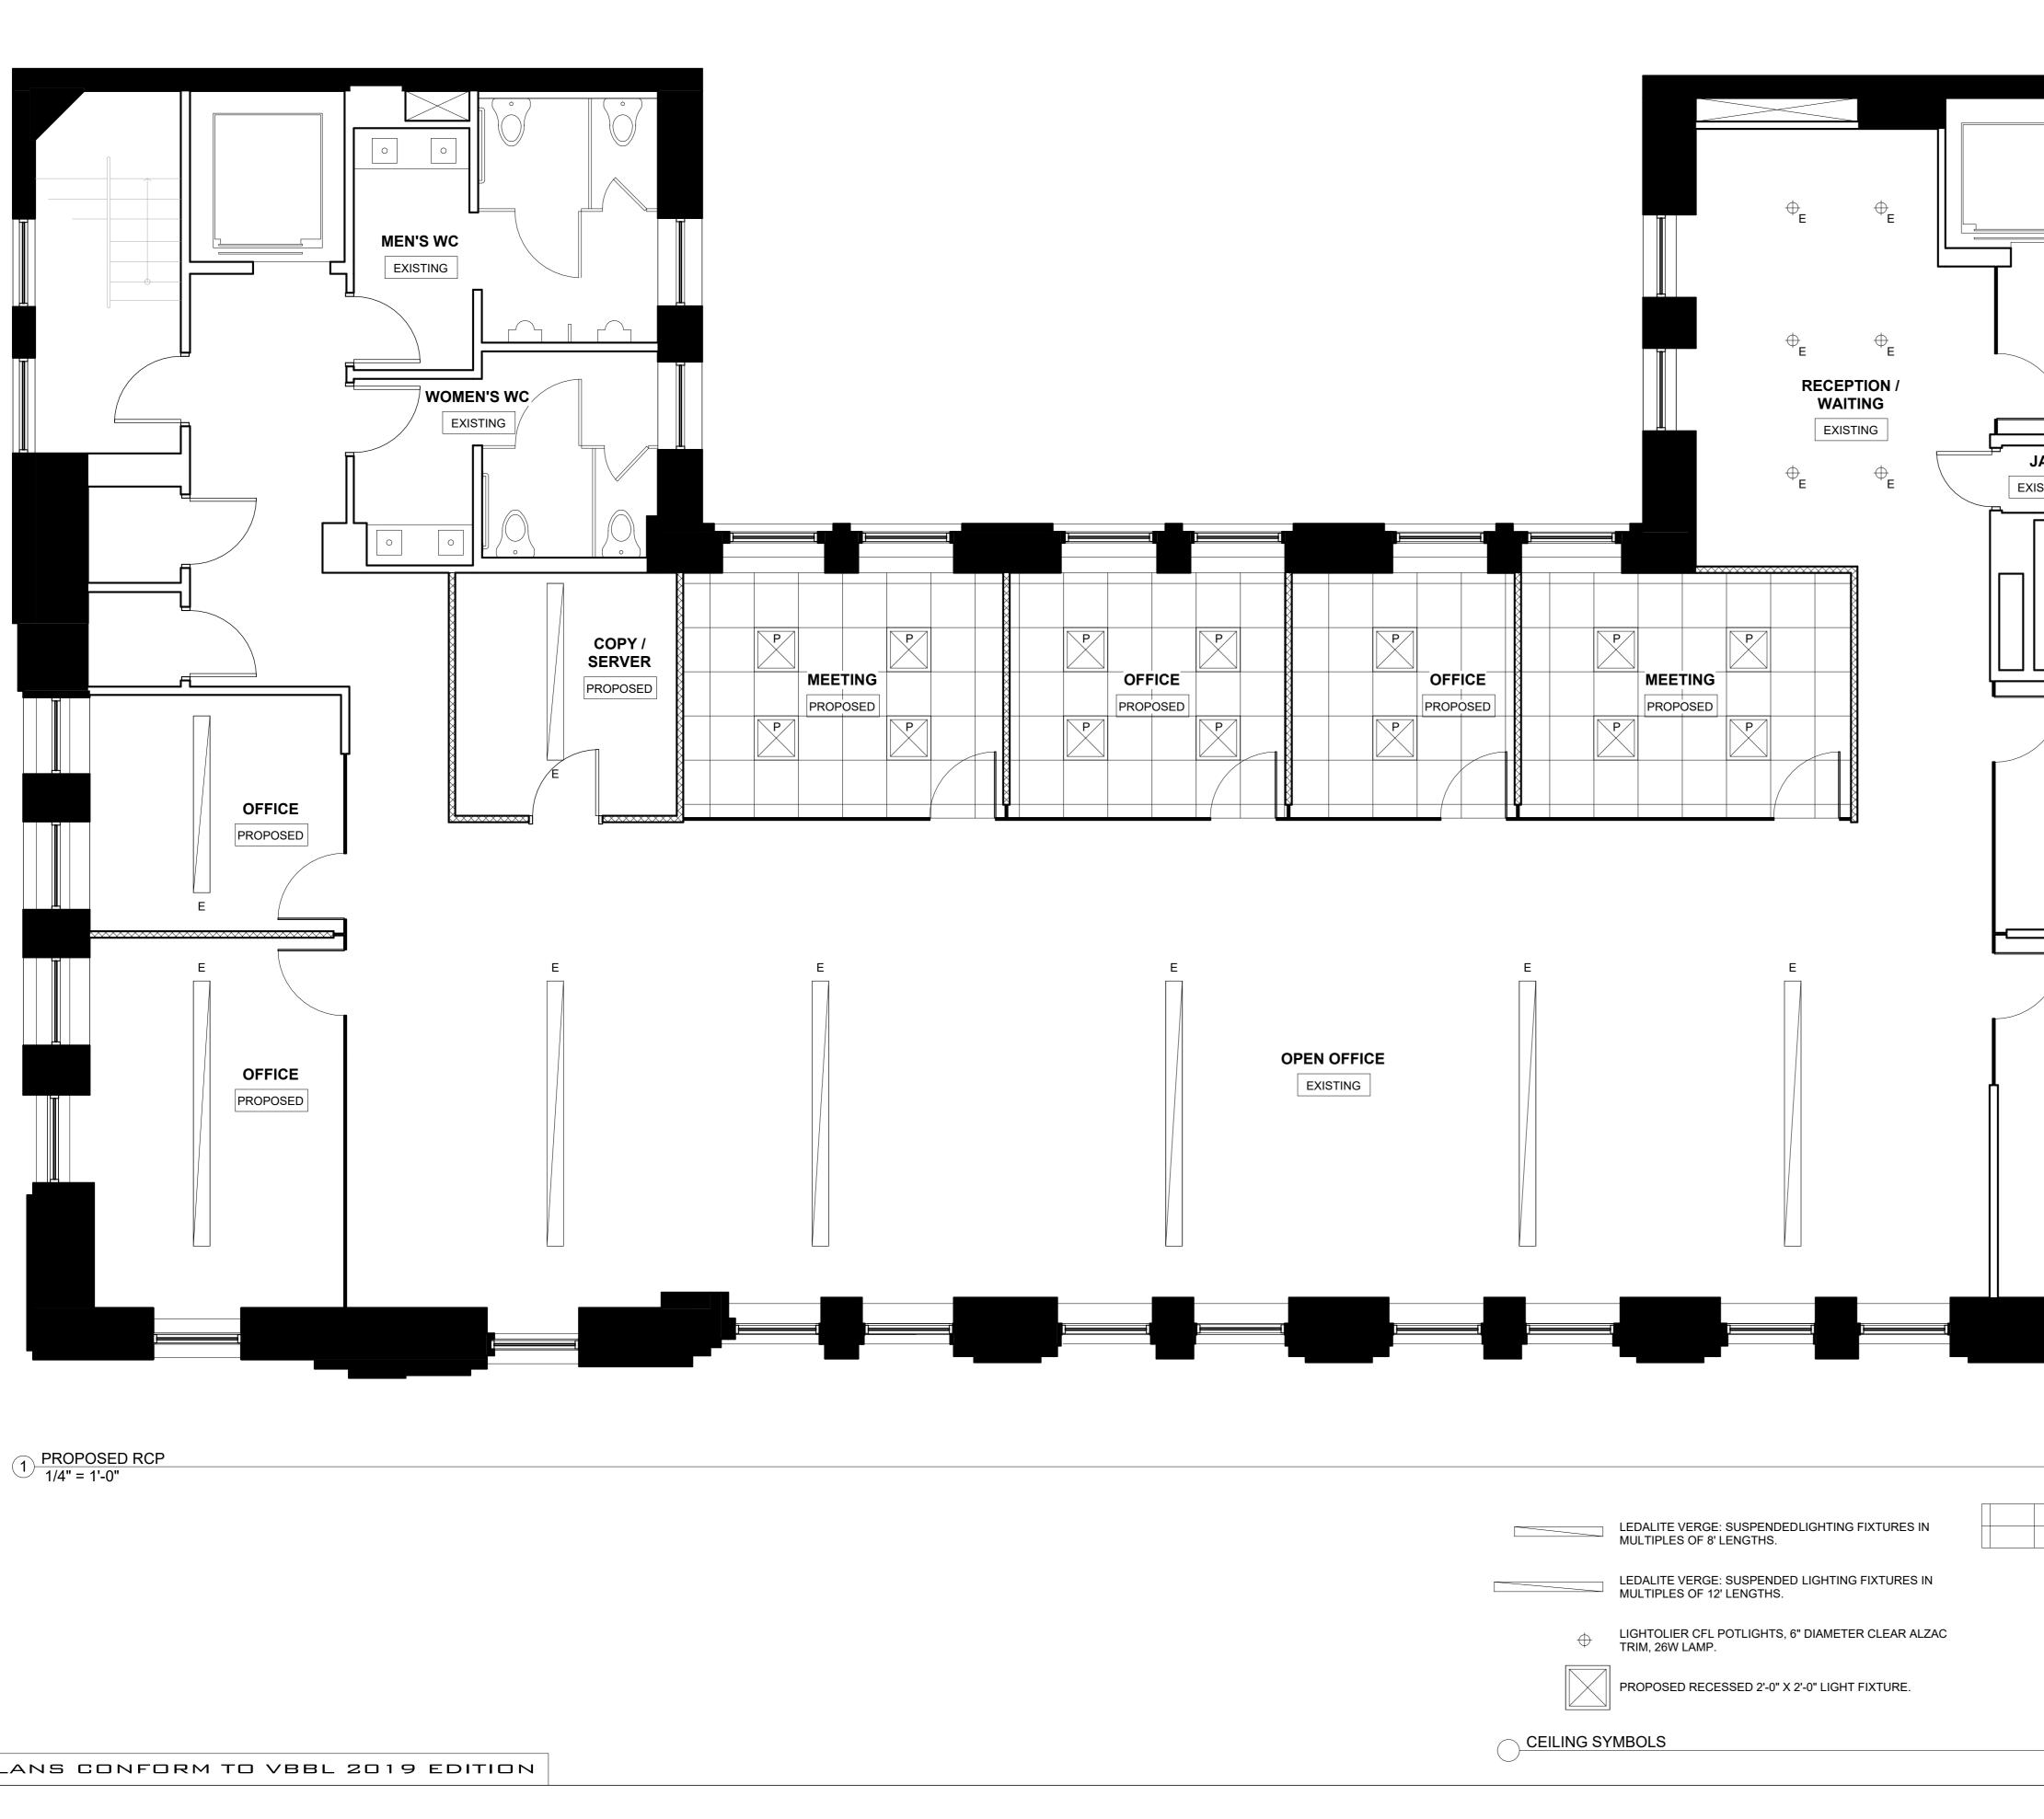

	MEETING		
	STAFF ROOM		
P DENOT DENOT R REPLAC	ES EXISTING ELECTRICAL DEVICES	TO BE	

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Sheet ListBP0.0Site PlanBP1.0Notes & DetailsBP2.0Proposed Plan		
BP3.0 Proposed RCP BP4.0 Existing Plan		
Revisions		
No°DescriptionDateAStarted preliminary design8/5/2024		
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Applied Science Technologists & Technicians of British Columbia		
34265 EDWARD VEGA CTECH		
UPG Property Group		
Tenant Improvement		
16TH Floor 675 West Hastings St,		
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Lot A Block 14 Plan EPP105179 District Lot 541 NWD Group 1 PID: 031-465-242		
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Drawn by EV Checked by BS/JE		
BP3.0		

